




ISO A1 594mm x 841mm

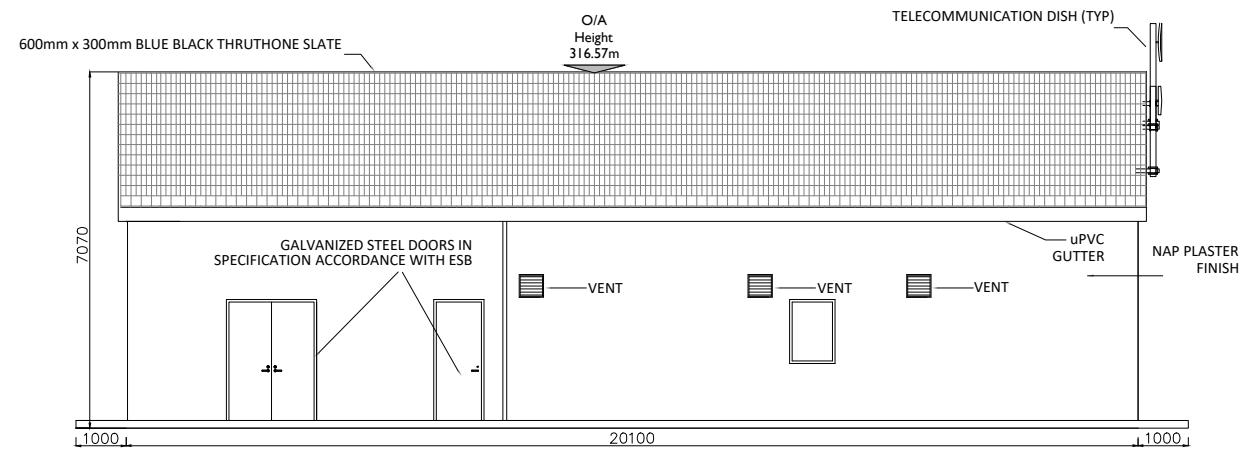


NORTH EAST ELEVATION
Scale : 1:75

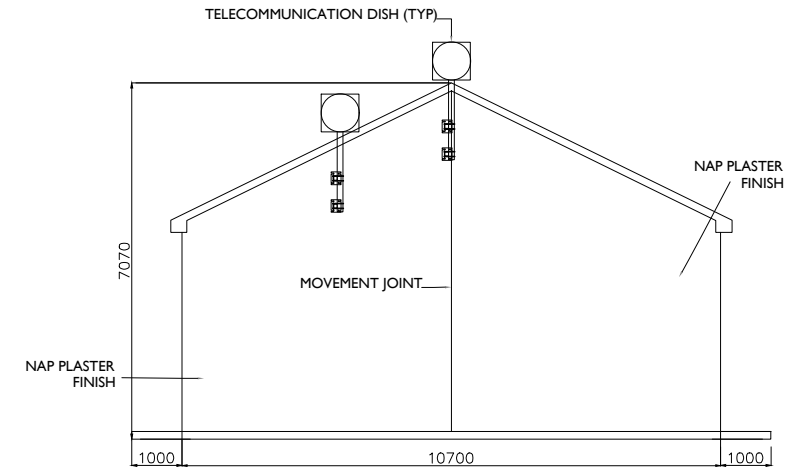


NORTH WEST ELEVATION
Scale : 1:75

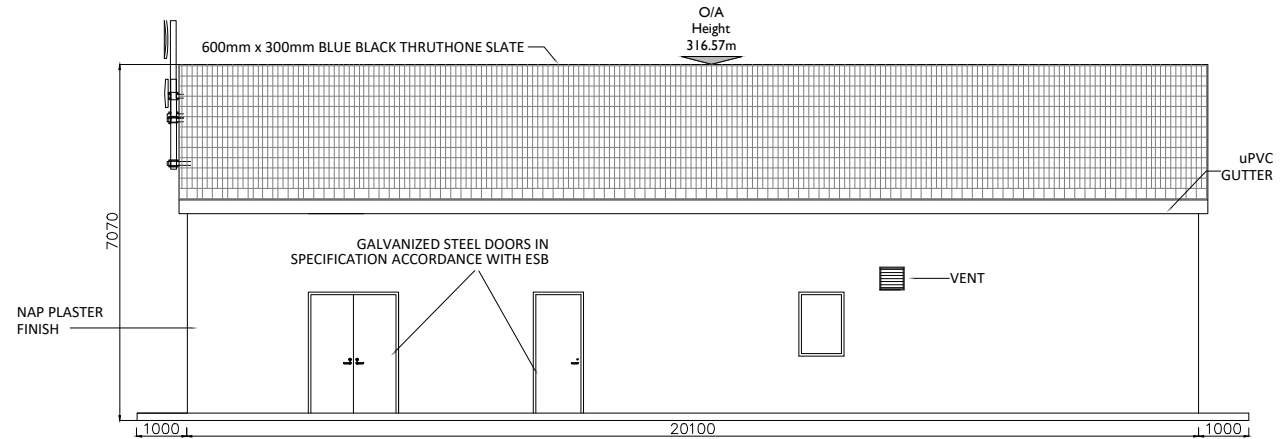


SOUTH WEST ELEVATION
Scale : 1:75

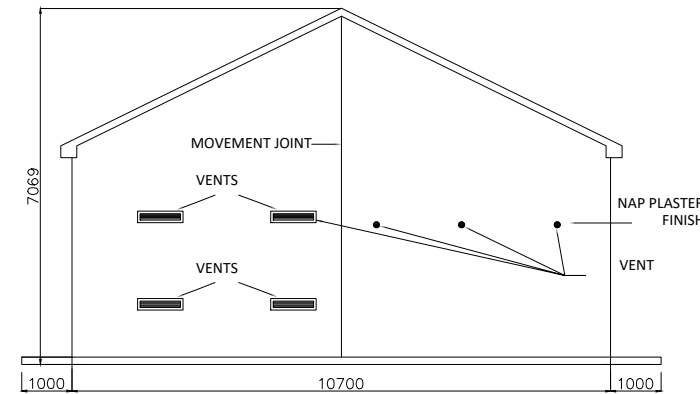

SOUTH EAST ELEVATION
Scale : 1:75

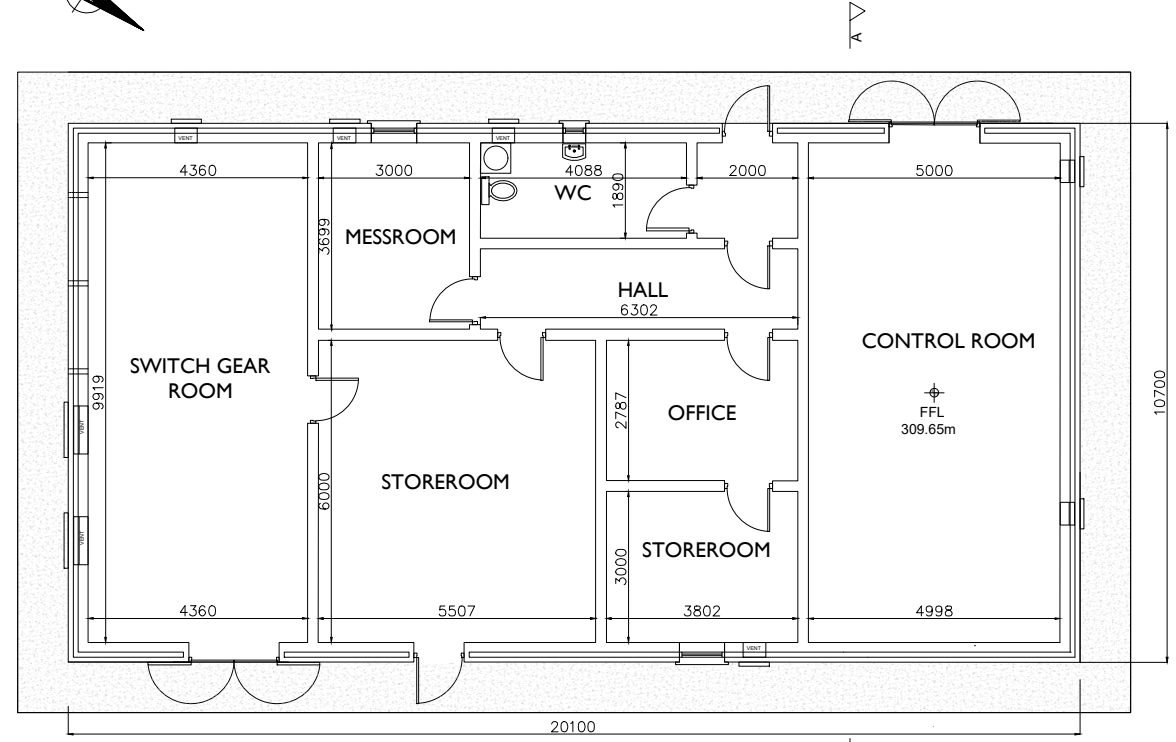

PLAN - IPP BUILDING
Scale : 1:100

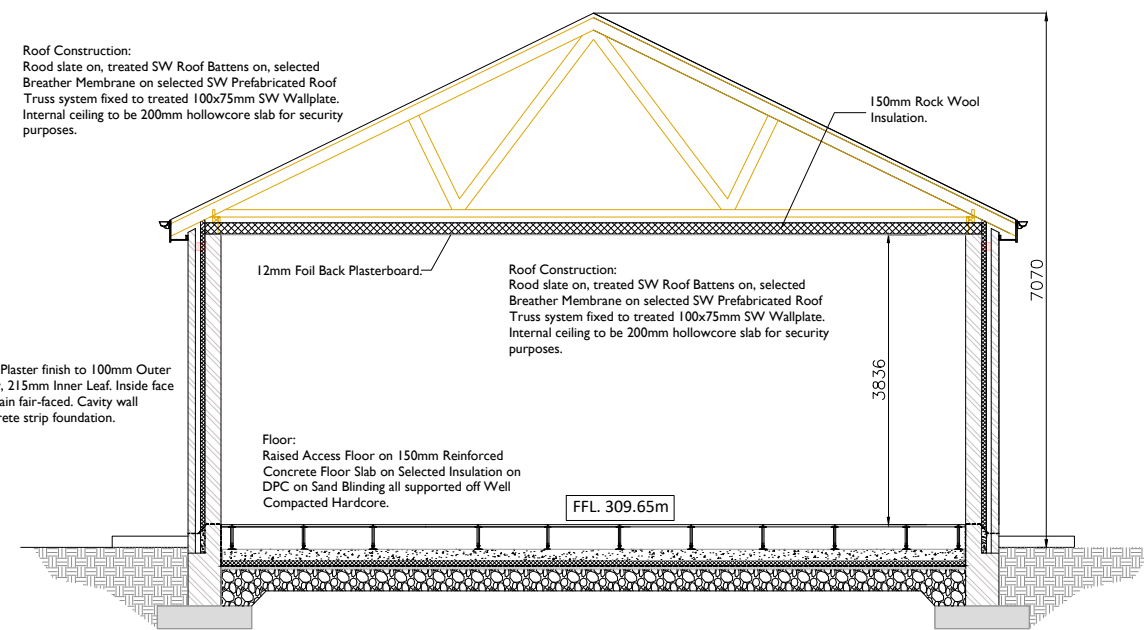

SECTION A-A
Scale : 1:50



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PROJECT
Coumngappul Wind Farm
110kV Grid Connection

CLIENT



CONSULTANTS

- NOTES:-**
1. Layout and Arrangements of Substation Building and Electrical Equipment is shown indicatively and for illustration purposes only.
 2. Dimensions shown are as per current EirGrid Specifications at the time of submission. Dimensions may vary at time of construction to reflect any revisions to EirGrid Specifications.
 3. Final Specifications of Buildings and Electrical Equipment is to be as per Eirgrid and ESB Specifications.
 4. The Elevation of the Compound will be depicted by localized Topography such that Cut/Fill Earthworks associated with the construction of the Compound are balanced.
 5. Heights shown are Levels (m) relative to Datum Malin Head

LEGEND:-

- Levels relative to Datum Malin Head shown thus 307.90m
- Concrete Footpath shown thus
- Foul Sewer shown thus
- Clean Storm Water shown thus
- Dirty Storm Water shown thus
- Water supply from Harvesting Tank shown thus

ISSUE/REVISION

I/R	DATE	DESCRIPTION
P3	02.10.2023	Issued for Planning
P2	26.07.2023	Issued For Planning
P1	13.01.2023	Issued for Planning

PROJECT NUMBER

05-828

SHEET TITLE

IPP Building - Plan & Elevations
& Section

SHEET NUMBER

05828-DR-182